
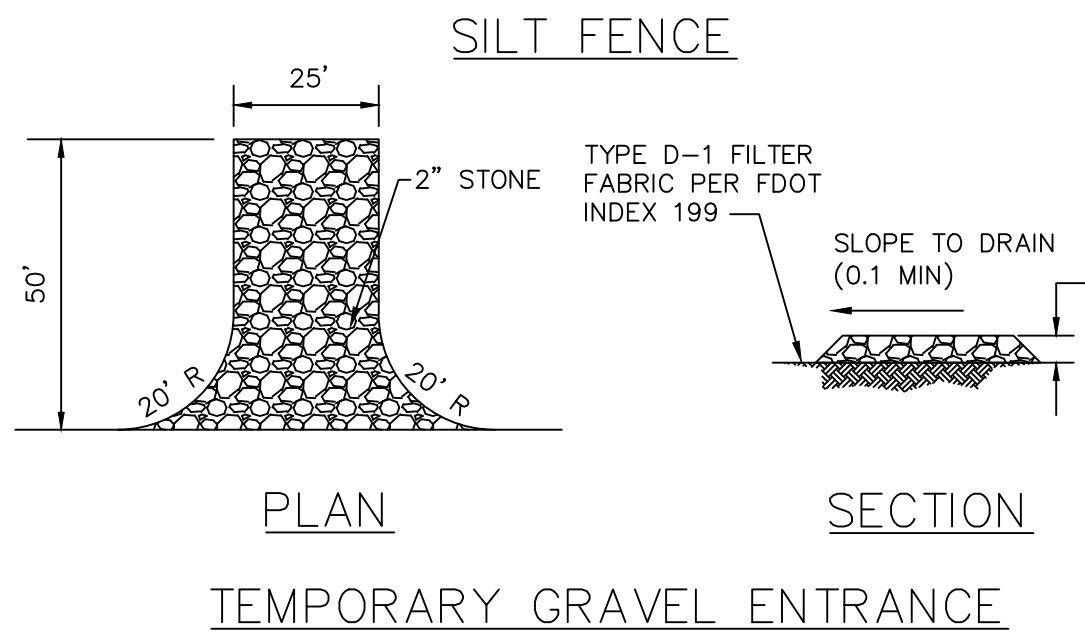


BUILDING 'A' FFE = 18.50' NGVD




BUILDING 'B' FFE = 18.50' NGVD

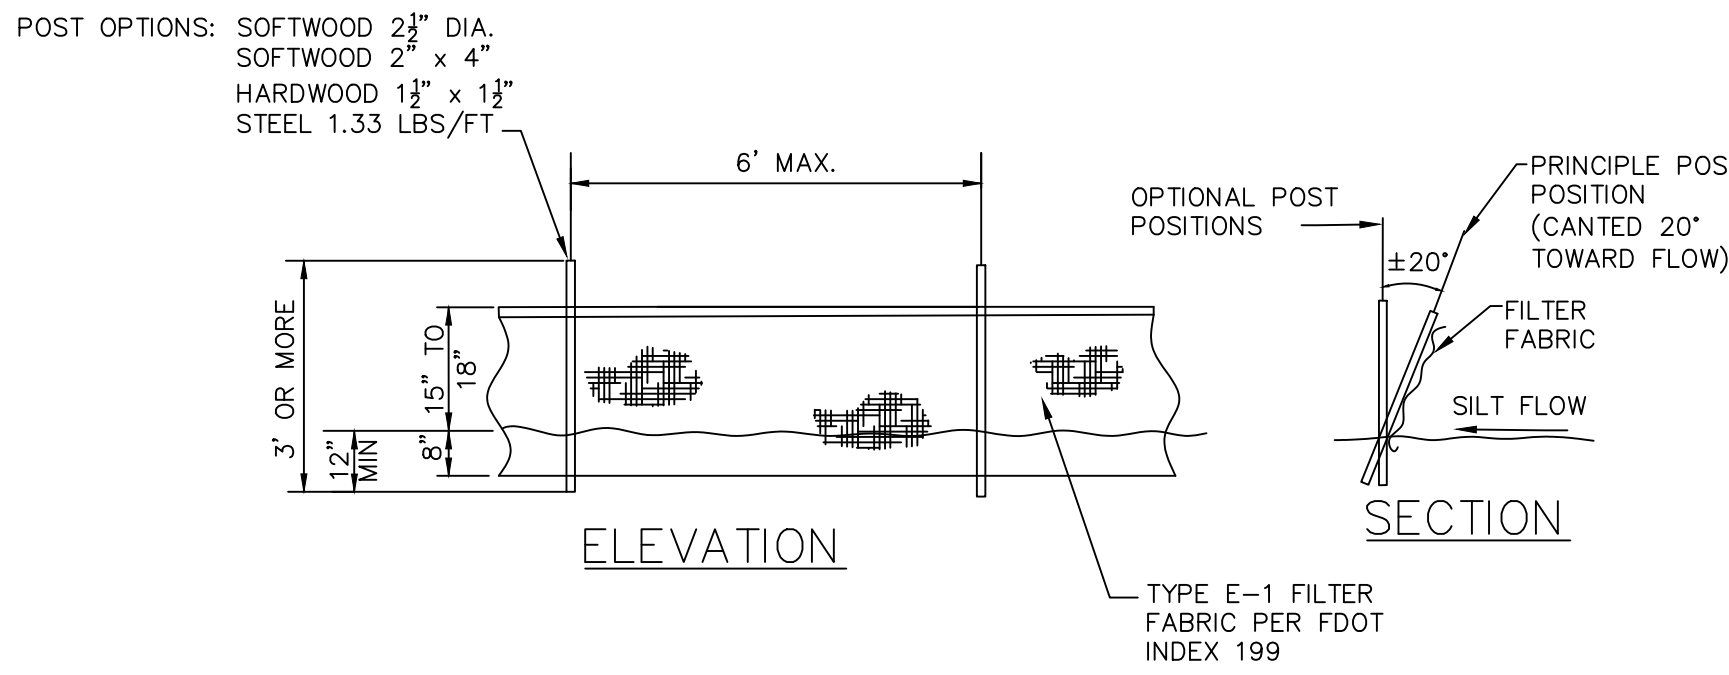

- POLLUTION PREVENTION NOTES:**
- ALL POLLUTION PREVENTION MEASURES SHALL BE STRICTLY ENFORCED.
  - PROVISIONS FOR CONTROL OF POLLUTION:
    - SUFFICIENT PRECAUTIONS SHALL BE TAKEN DURING CONSTRUCTION TO PREVENT THE RUN-OFF OF POLLUTING SUBSTANCES SUCH AS SILT, CLAY, FUELS, OILS, BITUMENS OR OTHER POLLUTING MATERIALS HARMFUL TO HUMANS, FISH, OR OTHER LIFE, INTO THE SUPPLIES AND SURFACE WATERS OF THE STATE OF FLORIDA. CONTROL MEASURES MUST BE ADEQUATE TO ASSURE THAT TURBIDITY IN THE RECEIVING WATER WILL NOT BE INCREASED MORE THAN 25 NEPHELOMETRIC TURBIDITY UNITS (NTU) ABOVE BACKGROUND UNLESS OTHERWISE PERMITTED. SPECIAL PRECAUTIONS SHALL BE TAKEN IN THE USE OF CONSTRUCTION EQUIPMENT TO PREVENT OPERATIONS WHICH PROMOTE EROSION, EROSION EVIDENT WITHIN THE LIMITS OF CONSTRUCTION OR OTHER AREAS AFFECTED BY THE CONTRACTOR SHALL BE THE RESPONSIBILITY OF THE CONTRACTOR.
    - FILL OUT A NOTICE OF INTENT FORM (FDEP FORM 62-621.300(4)(B)) AND SUBMIT IT TO THE FLORIDA DEPARTMENT OF ENVIRONMENTAL PROTECTION.
    - EXCAVATION OF WATER MANAGEMENT FACILITIES SHOULD OCCUR IMMEDIATELY AFTER CLEARING AND GRUBBING TO SERVE AS A SEDIMENT TRAP OR CATCHMENT FOR STORMWATER RUNOFF FROM EXPOSED SOILS.
    - CONSTRUCT PERIMETER BERM OR GRADE SITE TO PREVENT OFF-SITE DISCHARGE OF STORMWATER RUNOFF.
    - PLACE SILT FENCES OR HAY BALES TO CONTAIN EROSION IN AREAS PRONE TO STORMWATER RUNOFF EROSION VELOCITIES.
    - PROTECT EACH INLET THAT MAY RECEIVE RUNOFF FROM THE CONSTRUCTION SITE WITH SILT FENCE/FILTER FABRIC STAKED IN PLACE.
    - TAKE ALL REASONABLE PRECAUTIONS TO CONTROL DUST AND UNCONFINED PARTICULATE MATTER. THE APPLICATION OF WATER IS AN ACCEPTABLE DUST SUPPRESSANT ON ROADWAYS, STOCKPILES, AND ANY OTHER AREAS WITHIN THE PROJECT BOUNDARIES. DUST SUPPRESSANT WATER SHALL BE APPLIED IN SUCH A MANNER SO AS NOT TO PRODUCE EXCESS RUNOFF AND EROSION.
    - TAKE PRECAUTIONS IN THE USE OF CONSTRUCTION EQUIPMENT TO PREVENT OPERATIONS WHICH PROMOTE EROSION.
  - OTHER CONTROLS AND MATERIAL MANAGEMENT PRACTICES:
    - HAZARDOUS WASTE - DISPOSE OF IN A MANNER SPECIFIED BY LOCAL OR STATE REGULATIONS.
    - NOISE - MINIMIZE NOISE CAUSED BY THE OPERATION OF EQUIPMENT. ABIDE BY ALL LOCAL REGULATIONS COVERING NOISE CONTROL.
    - ODORS - DO NOT CAUSE OBJECTIONABLE ODORS TO BE GENERATED.
    - OFFSITE VEHICLE TRACKING - PROVIDE A ROCK CONSTRUCTION ENTRANCE TO REDUCE VEHICLE TRACKING OF SEDIMENTS. DUMP TRUCKS HAULING MATERIAL FROM THE CONSTRUCTION SITE SHALL BE COVERED WITH A TARPULIN.
    - OPEN BURNING - NO OPEN FIRES OR BURNING OF MATERIALS.
    - PAINTS - ALL CONTAINERS SHALL BE TIGHTLY SEALED AND STORED WHEN NOT REQUIRED FOR USE. EXCESS PAINT SHALL NOT BE DISCHARGED TO THE STORM SEWER SYSTEM, BUT WILL BE PROPERLY DISPOSED OF ACCORDING TO THE PAINT MANUFACTURER'S INSTRUCTIONS AND STATE OR LOCAL REGULATIONS.
    - PETROLEUM PRODUCTS - MONITOR ON-SITE VEHICLES AND TANKS FOR LEAKS. THEY SHALL RECEIVE REGULAR PREVENTIVE MAINTENANCE TO REDUCE THE CHANCE OF LEAKAGE. STORE PETROLEUM PRODUCTS IN TIGHTLY SEALED CONTAINERS, WHICH ARE CLEARLY LABELED. USE ASPHALT SUBSTANCES ACCORDING TO THE MANUFACTURER'S RECOMMENDATIONS. PROVIDE SECONDARY CONTAINMENT FOR ALL ABOVE GROUND FUEL TANKS.
    - SANITARY WASTE - COLLECT ALL SANITARY WASTE FROM THE PORTABLE UNITS AT LEAST TWICE PER WEEK.
    - WASTE MATERIALS - COLLECT AND STORE ALL WASTE MATERIALS IN A SECURELY COVERED METAL DUMPSTER PROVIDED BY A LICENSED SOLID WASTE MANAGEMENT COMPANY. DEPOSIT ALL TRASH AND CONSTRUCTION DEBRIS FROM THE SITE IN THE DUMPSTER. THE DUMPSTER IS TO BE EMPTIED AS NEEDED SO THERE IS NO OVERFLOW. HAUL TRASH TO A STATE APPROVED LANDFILL FACILITY.


- LEGEND:**
- |       |                        |
|-------|------------------------|
| CO    | CLEANOUT               |
| EL    | ELEVATION              |
| EXIST | EXISTING               |
| FFE   | FINISH FLOOR ELEVATION |
| FT    | FEET OR FOOT           |
| NTS   | NOT TO SCALE           |
| R/W   | RIGHT-OF-WAY           |
| SF    | SQUARE FEET            |
| w/    | WITH                   |
| SAN   | SANITARY               |

- LEGEND: (ABBREVIATIONS)**
- |       |                        |
|-------|------------------------|
| CO    | CLEANOUT               |
| EL    | ELEVATION              |
| EXIST | EXISTING               |
| FFE   | FINISH FLOOR ELEVATION |
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| R/W   | RIGHT-OF-WAY           |
| SF    | SQUARE FEET            |
| w/    | WITH                   |
| SAN   | SANITARY               |
- THE FOLLOWING PROCEDURES ARE TO BE IMPLEMENTED DURING CONSTRUCTION:**
- EVERY WEEK THE CONSTRUCTION MANAGER IS TO INSPECT THE FOLLOWING POLLUTION PREVENTION FACILITIES TO INSURE THAT THEY ARE IN PLACE AND WORKING PROPERLY. IF THEY ARE FOUND NOT TO BE WORKING PROPERLY THE CONSTRUCTION MANAGER WILL TAKE CORRECTIVE ACTION WITHIN FORTY-EIGHT (48) HOURS:
    - MAINTENANCE OF OPERATING CONDITION OF THE TWO FOOT (2) HIGH EROSION FENCE.
    - MAINTENANCE OF OPERATING CONDITION OF ALL HAY BALES PLACED AROUND INLETS AND LOW POINTS ON THE PERIMETER.
    - DISPOSAL OF ALL CONSTRUCTION DEBRIS TO AN OFF SITE LICENSED WASTE DISPOSAL FACILITY.
    - INSPECTION OF ALL INLETS WHERE FILTER FABRIC OR ITS EQUIVALENT HAS BEEN PLACED IN THE STRUCTURE. CLEAN AND REMOVE SEDIMENTS AND TRASH AS NEEDED.
    - MAINTENANCE OF ALL TURBIDITY BARRIERS.
  - THERE WILL BE NO MAINTENANCE OF VEHICLES PERFORMED ON-SITE. THERE WILL BE NO DISPENSING OR DISPOSAL OF MOTOR OIL, HYDRAULIC FLUID OR FUEL OIL ON-SITE.
  - EVERY THREE MONTHS DURING CONSTRUCTION AND ONE MONTH AFTER THE COMPLETION OF ALL CONSTRUCTION ACTIVITIES THE CONTRACTOR IS TO INSPECT AND CLEAN OUT ALL CATCH BASINS AND INLETS, RELIEVING RUNOFF FROM THE SITE.
  - IF MODIFICATIONS ARE MADE TO THE POLLUTION PREVENTION PLAN THEY MUST BE SUBMITTED IN WRITING.

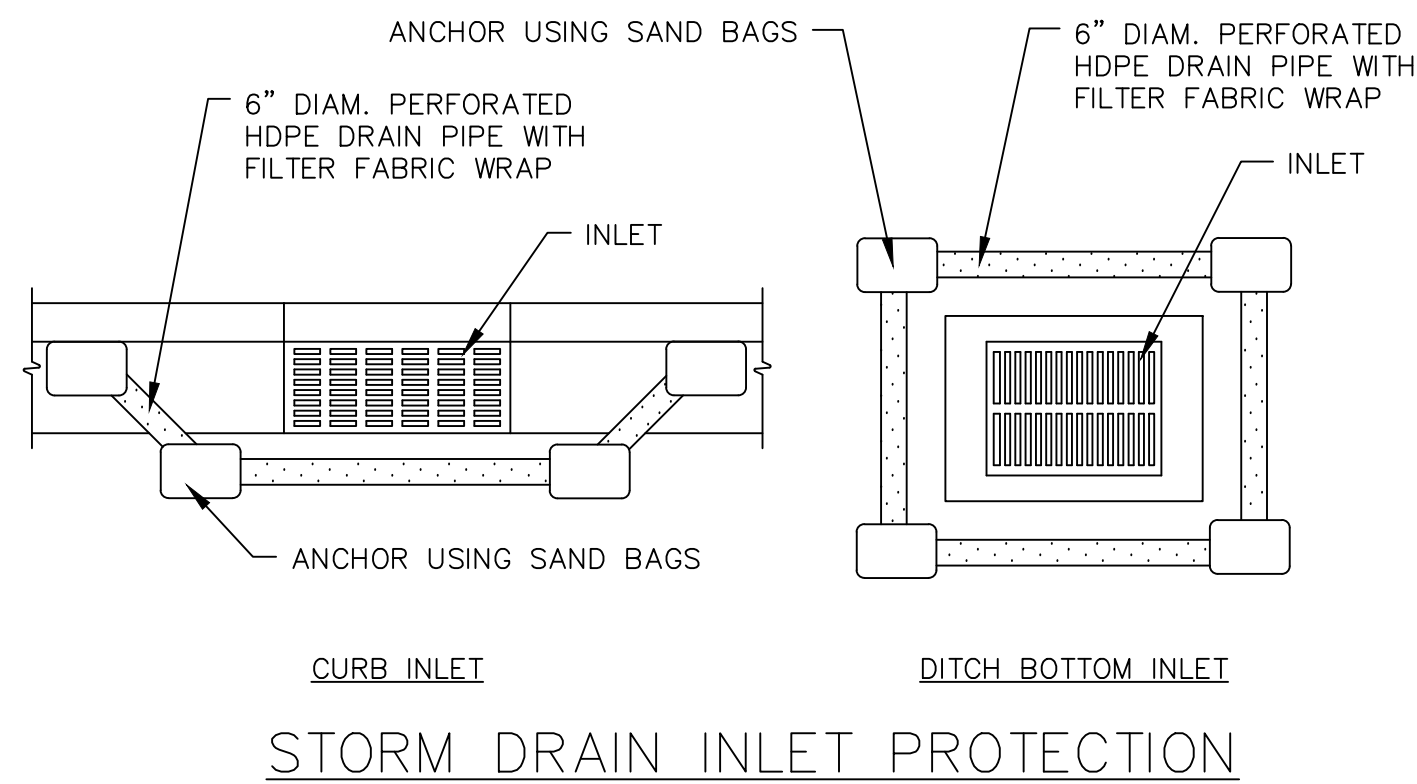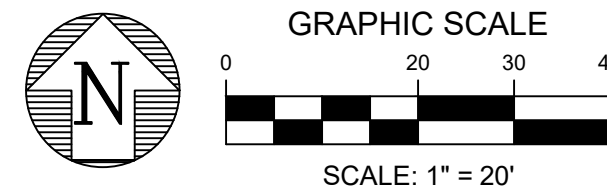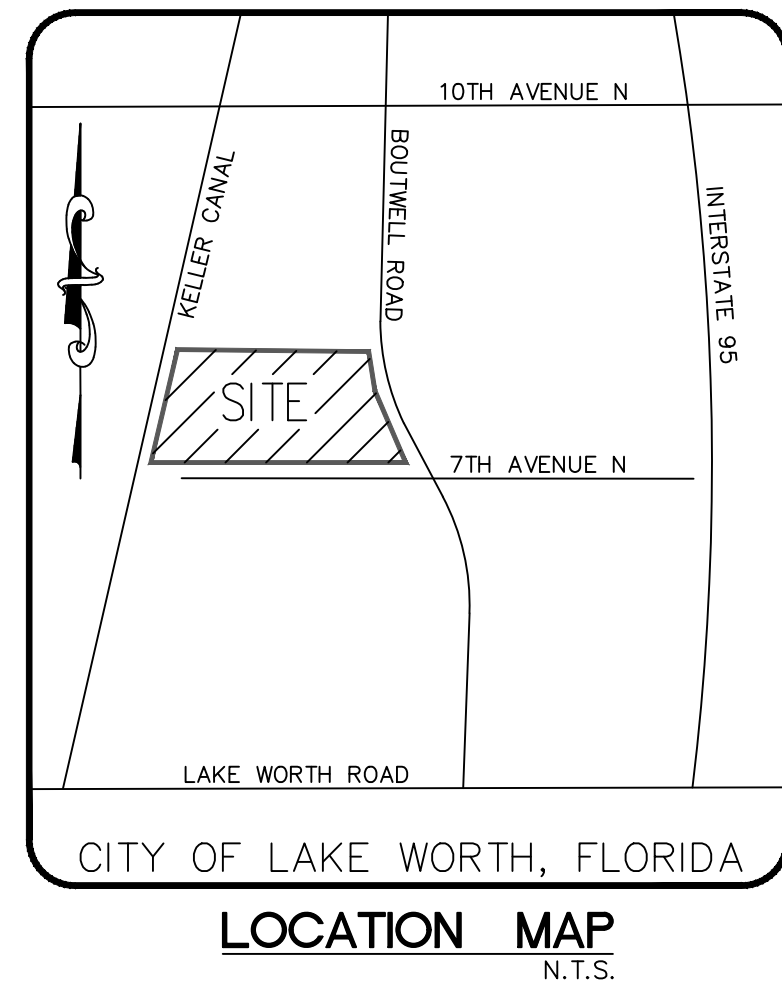

**LEGEND:**

**PROPOSED**

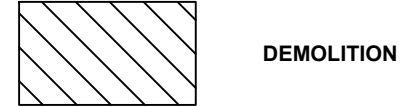


**LEGEND: (ABBREVIATIONS)**

- |       |                        |
|-------|------------------------|
| CO    | CLEANOUT               |
| EL    | ELEVATION              |
| EXIST | EXISTING               |
| FFE   | FINISH FLOOR ELEVATION |
| FT    | FEET OR FOOT           |
| NTS   | NOT TO SCALE           |
| R/W   | RIGHT-OF-WAY           |
| SF    | SQUARE FEET            |
| w/    | WITH                   |
| SAN   | SANITARY               |

**LEGEND**

- |        |                         |
|--------|-------------------------|
| —      | EASEMENT                |
| — SD — | EXISTING DRAINAGE       |
| — SS — | EXISTING SANITARY SEWER |
| — WM — | EXISTING WATERMAIN      |
| —      | RIGHT-OF-WAY            |

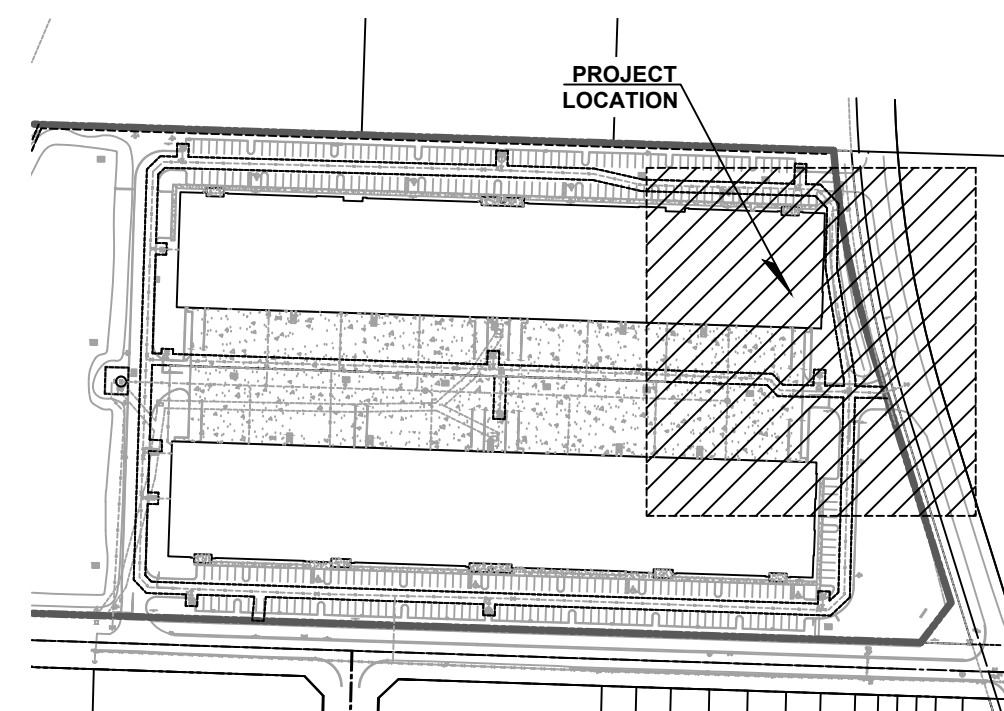

**PROJECT LOCATION MAP**  
SCALE: 1" = 250'

**90%  
SUBMITTAL**



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**FOOD BANK  
BOUTWELL RD, LAKE WORTH  
PALM BEACH COUNTY  
DEMOLITION AND EROSION CONTROL PLAN**

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DATE	DRAWN	PROJECT	ENGINEER	PROJECT	MANAGER	CHECKED
DECEMBER 2022	KG	KJ	KJ	RB	KJ	
DATE						

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